

TRANSPORT AND TRAFFIC PLANNING ASSOCIATES

Suite 502, Level 5, 282 Victoria Avenue, Chatswood NSW 2067 P (02) 9411 5660 F (02) 9904 6622 W ttpa.com.au E meg@ttpa.com.au

1 October 2021 Ref: 004OH/2021

Vaughan Milligan Director Vaughan Milligan Development Consulting Pty Ltd By Email: <u>vmdc@bigpond.net.au</u>

Dear Vaughan,

Proposed Residential Development 11B Hill Street, Warriewood DA2021/0715 Response to Council's Request for Additional Information

This letter is prepared to address Council's Request for Additional Information for traffic and parking matters dated 10/08/2021. The revised development plans prepared by JJ Drafting are provided in Appendix A.

The following details Council's comments and associated TTPA's response are provided in the table below.

RFI No.	TTPA's Response
4. A minimum of 3.0 m wide paved access way is to be provided to service all lots.	A minimum of 3m wide paved access way is proposed to both lots.
The minimum driveway wide has not been detailed, additionally a vehicle turning template for a B85 vehicle to be overlain on the turn into proposed Lot no 2.	Swept path assessments provided in Appendix B demonstrate satisfactory manoeuvring for a B85 entering and exiting both lots.
6. Passing bay will be required. where the proposed access driveway is more than 30 metres in length. The passing bay must be 5.0m wide and 10 m long	Single two-way driveway for residential dwellings is common in Sydney and has traditionally operated without any safety concerns due to the very low level of traffic movements.
shall be provide. The passing bay has not been provided.	Some examples of other similar driveways in the adjoining localities include:
	 65m long 2.6m-wide driveway with access to 4 dwellings (32, 38, 40 and 42 Lakeview Parade Warriewood)
	 40m long 4.4m-wide driveway with access to 2 dwellings (16 & 16a Lakeview Parade Warriewood)

shoulders (0.1%). In summar associated	of Hill Stre y, the prov signage w	et due to an e ision of the sto vill be adequate	to stop temporarily exiting vehicle is neg op and go light syste e to ensure the car p ely without a passing	gligible em and parking
3	2	0.0%	0.000	
2	1	0.1%	0.001	
1	0	2.4%	0.025	
0	0	system 97.5%	1.000	
units in the system	in Queue	of "n" units in the	"n" units in the system or more	
Transporta p303) was outbound t (during the seconds,	tion and T used to ca raffic volur AM peak the result	raffic Enginee alculate the ex ne of 3 inboun (hour) as we	sment based or ring Handbook (ITE pected delay. Adop d vehicles and 1 our Il as a service rate and expected dela Probability of	i) (See ting an tbound of 30
will rem - the sigr entering off at al such, th	nain green nal system g vehicles Il times, ex ne light will	for 30 seconds is to be progra at all times. Th cept when the	nds, while "S1" and s prior to returning to ammed to process his means that "SE" re is a car exiting. A ny visual and light operties.	o red. will be
vehicle garage be supp installe light sp - Upon a	detector lo (facing ou plemented d for the si ills. ctivation b	bop would be in tbound vehicle by remote cor gnal lights in fi y exiting vehic	led as "S1" and "S2' nstalled in front of e es). The system will ntrols. Louvres will b ront of garages to lir les, the "SE" lantern "S2" will both turn g	ach also e nit the will
the site (facing will rem vehicle	access po inbound vo nain inactiv detector lo	bint supplemer ehicle) – labell e and turn red pop located in	post would be instanted by 2 convex mined as "SE". The land when activated by front of each garage	rors tern the 9.
The development proposes a stop and go light system which comprises (See Appendix B):				

The Copyright and ownership of all prepared documents remains the property of Transport and Traffic Planning Associates until full payment is made. Transport and Traffic Planning Associates retains the right to remove documentation from the relevant assessing authorities if payment is not made within the terms of the associated invoice.

I trust the above is sufficient for your purpose. Should you have any questions or require further information, please do not hesitate to contact me on (02) 9411 5660.

Yours faithfully

Siew Hwee Kong (Meg) BSc, MSc Civil Engineering Associate Transport and Traffic Planning Associates Design Practitioner Registration Number: DEP0000127 Professional Engineer Registration Number: PRE0000121

APPENDIX A Assessed Plans

The Copyright and ownership of all prepared documents remains the property of Transport and Traffic Planning Associates until full payment is made. Transport and Traffic Planning Associates retains the right to remove documentation from the relevant assessing authorities if payment is not made within the terms of the associated invoice.


PROPOSED NEW DWELLING TO A PROPOSED SUBDIVISION 11B HILL STREET - WARRIEWOOD 2102 - RESIDENCE 1




NOTES (E & OE)		REV:	DATE:	DESCRIPTION:	PROJECT DETAILS:	DATE:	DRAWN BY:	SCALE:
 All structures including stormwater & drainage to engineer's details. Do not obtain dimensions by scaling drawings. 	II Drafting				PROPOSED NEW DWELLING			
All dimensions are to be checked on site prior to starting work.	<i>JJ 2 i iJ i iJ</i>				11B HILL STREET. WARRIEWOOD NSW 2102	MARCH/21	LB	@ A3
 These drawings are to be read in conjunction with all other consultant's drawings and specifications. 	174 Garden St, North Narrabeen, NSW, 2101				TID HILL STREET, WARRIEWOOD NSW 2102			_
All workmanship & materials shall be in accordance with the requirements of current editions	PO Box 687, Dee Why, NSW, 2099				DRAWING TITLE:			
including amendments of the National Construction Code, relevant Australian Standards & local council requirements.	Mob. 0414 717 541				1	JOB No:	CHECKED BY:	DRAWING No:
New materials are to be used throughout unless otherwise noted.	Email. jjdraft@tpg.com.au				COVER SHEET	854/20	.1.1	DA.00
Concrete footings, slab, structural beams or any other structural members are to be designed by a practicing engineer.	www.jjdrafting.com.au					004/20	00	DA.00
by a practicing engineer.								

INDEX OF DRAWINGS:

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by a practicing engineer.

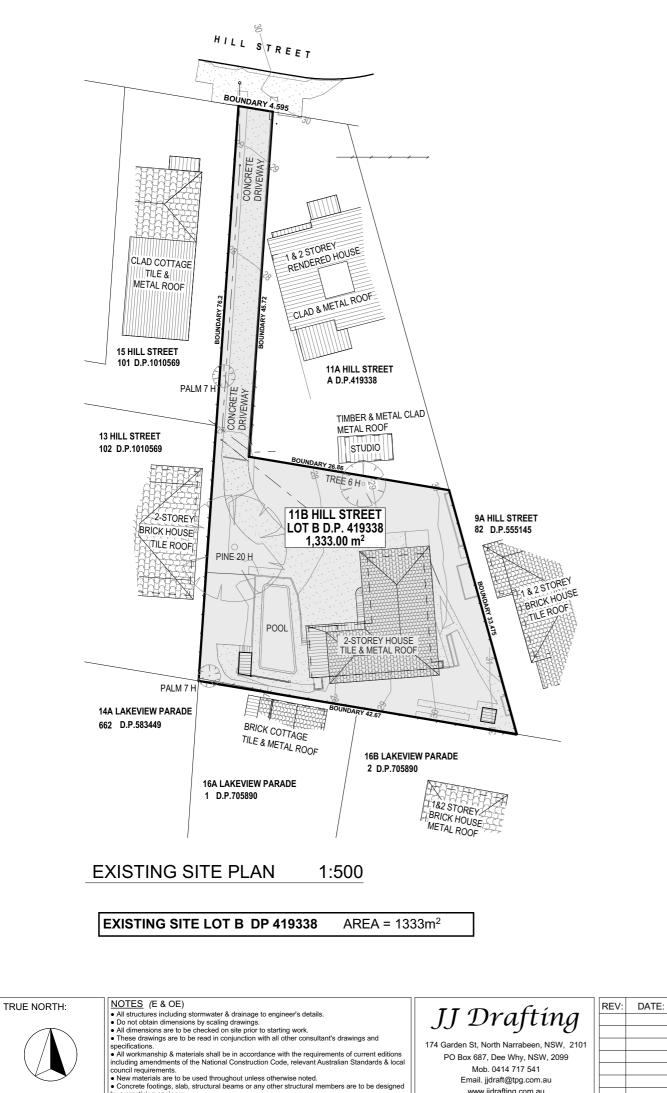

PROPOSED SUBDIVISION PLAN

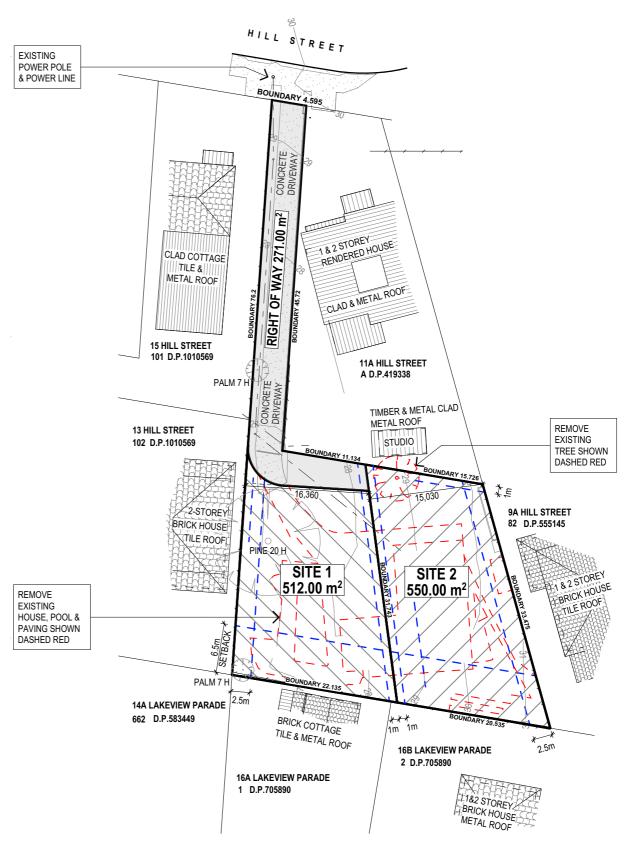PROPOSED SITE 1	AF
PROPOSED SITE 2	AF
PROPOSED RIGHT OF WAY& EASEMENT	AR
PROJECT DETAILS: PROPOSED NEW DWELLING 11B HILL STREET, WARRIEWOOD NSW 2102	
DRAWING TITLE: SITE & SUBDIVISION PLANS	


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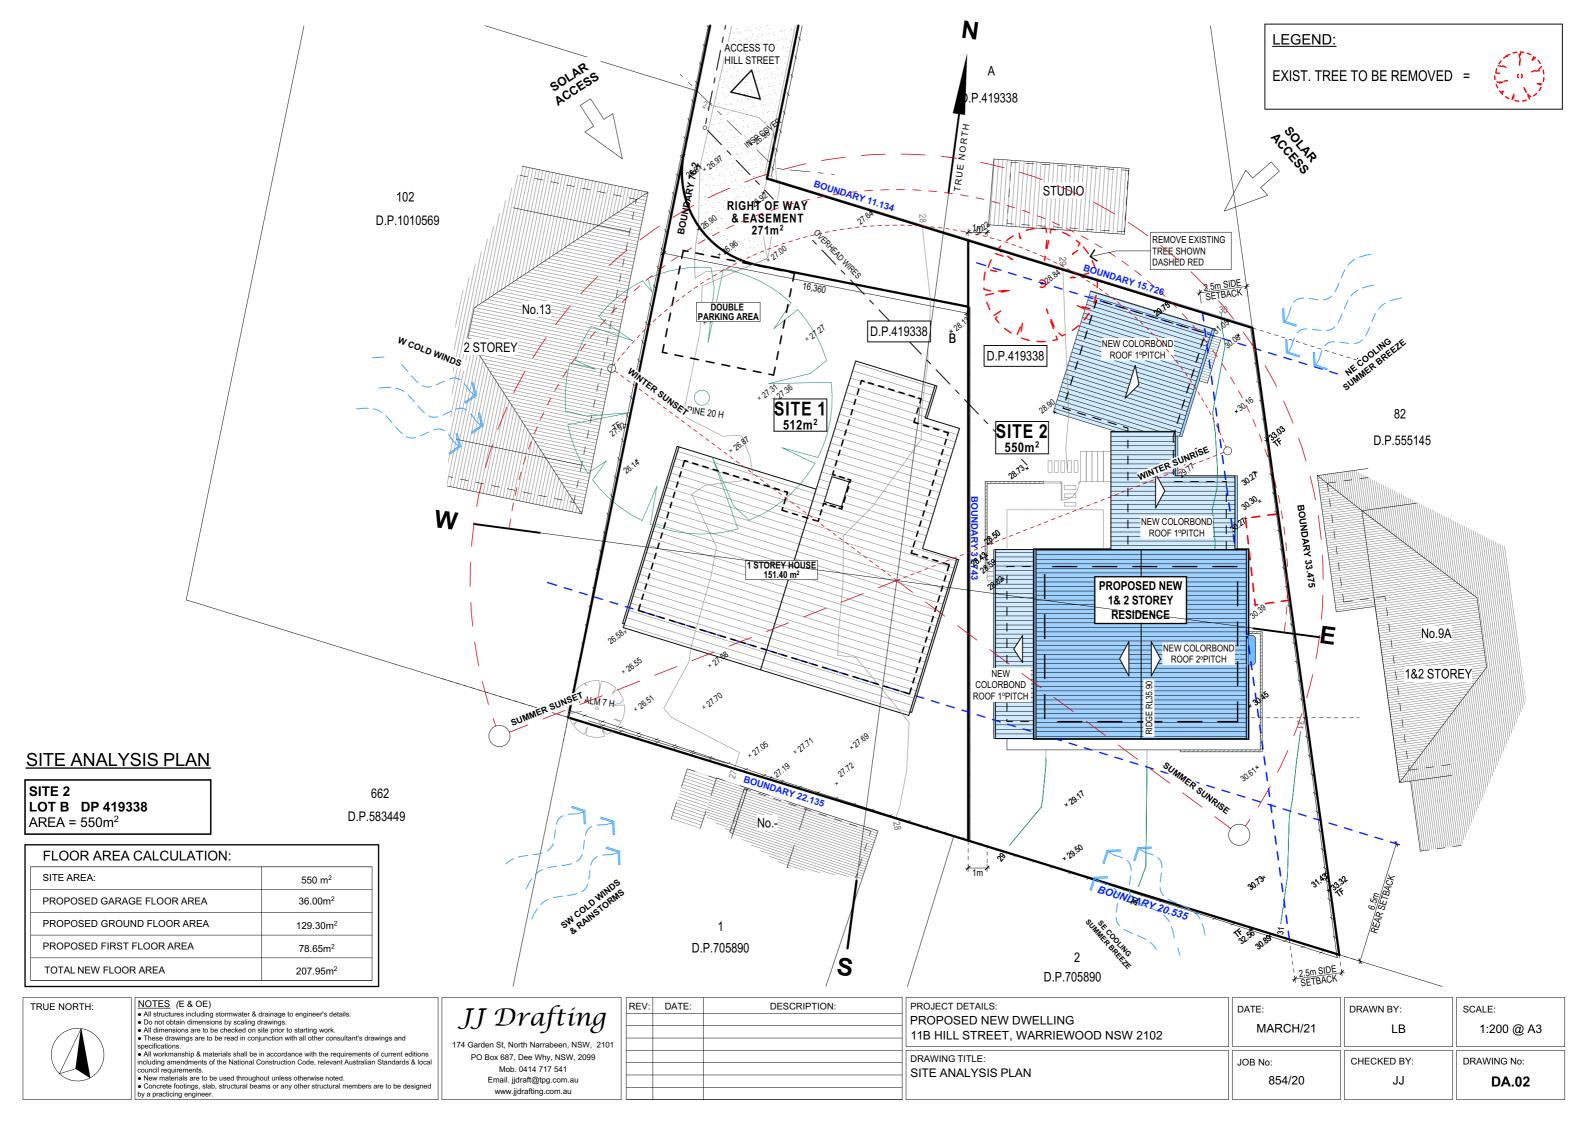
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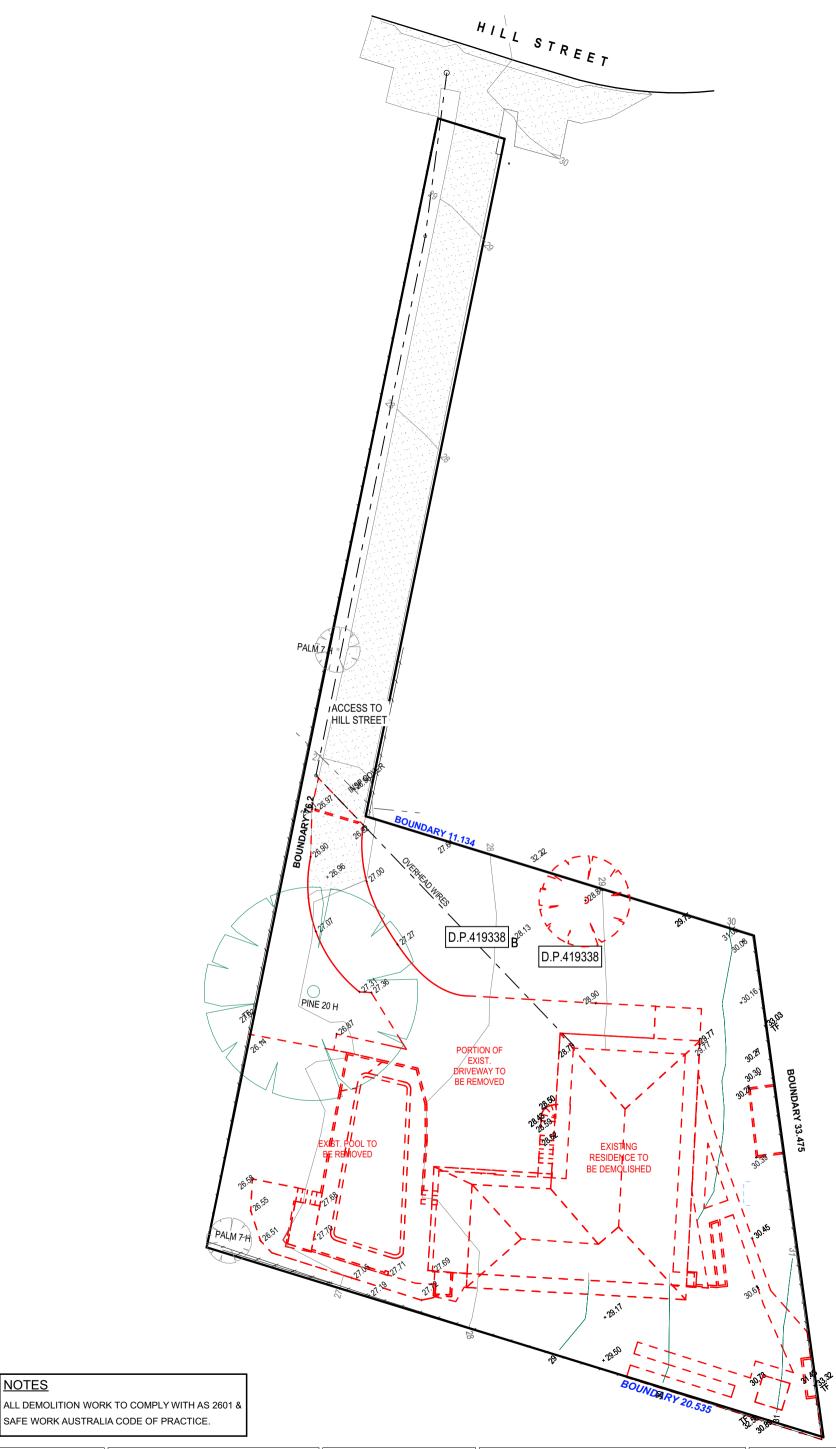
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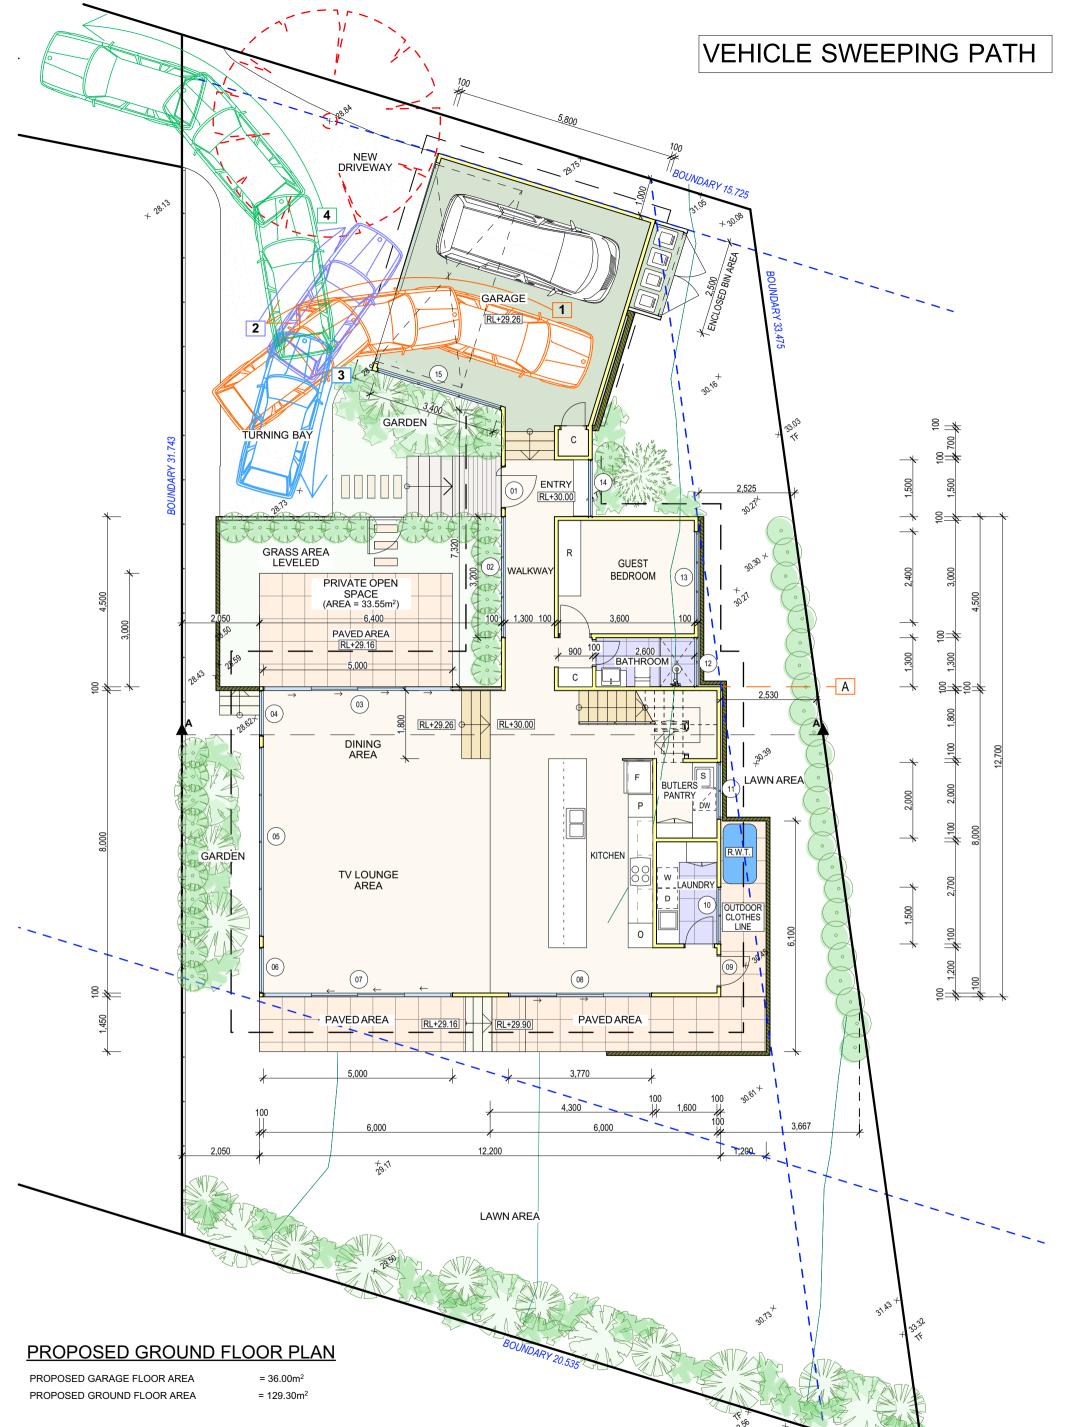







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 An structures including summaries of drainage to engineer s details. Do not obtain dimensions by scaling drawings. All dimensions are to be checked on site prior to starting work. These drawings are to be read in conjunction with all other consultant's drawings and the prior for the starting work. 	2 0	PROPOSED ALTERATIONS AND ADDITIONS 11B HILL STREET, WARRIEWOOD NSW 2102	SEPTEMBER/20	LB	1:250 @ A3	
	 Consultants of drawings and specifications. All workmanship & materials shall be in accordance with the requirements of current editions including amendments of the National Construction Code, relevant Australian Standards & local council requirements. New materials are to be used throughout unless otherwise noted. Concrete footings, slab, structural beams or any other structural members are to be designed by a practicing engineer. 	PO Box 687, Dee Why, NSW, 2099 Mob. 0414 717 541 Email: iidraff@too.com.au	DRAWING TITLE:	JOB No:	CHECKED BY:	DRAWING No:
			DEMOTION PLAN	854/20	IJ	DA.03

<u>NOTES</u>

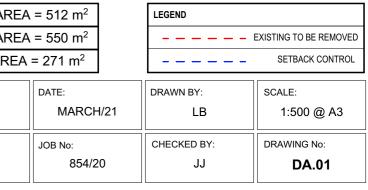

TRUE NORTH:	NOTES (E & OE) • All structures including stormwater & drainage to engineer's		PROJECT DETAILS:	DATE:	DRAWN BY:	SCALE:
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 National Construction Code, relevant Australian Standards & local council requirements. New materials are to be used throughout unless otherwise noted. Concrete footings, slab, structural beams or any other structural members are to be designed by a practicing engineer. 	Mob. 0414 717 541 Email. jjdraft@tpg.com.au www.jjdrafting.com.au	GROUND FLOOR PLAN	854/20	JJ	DA.04	

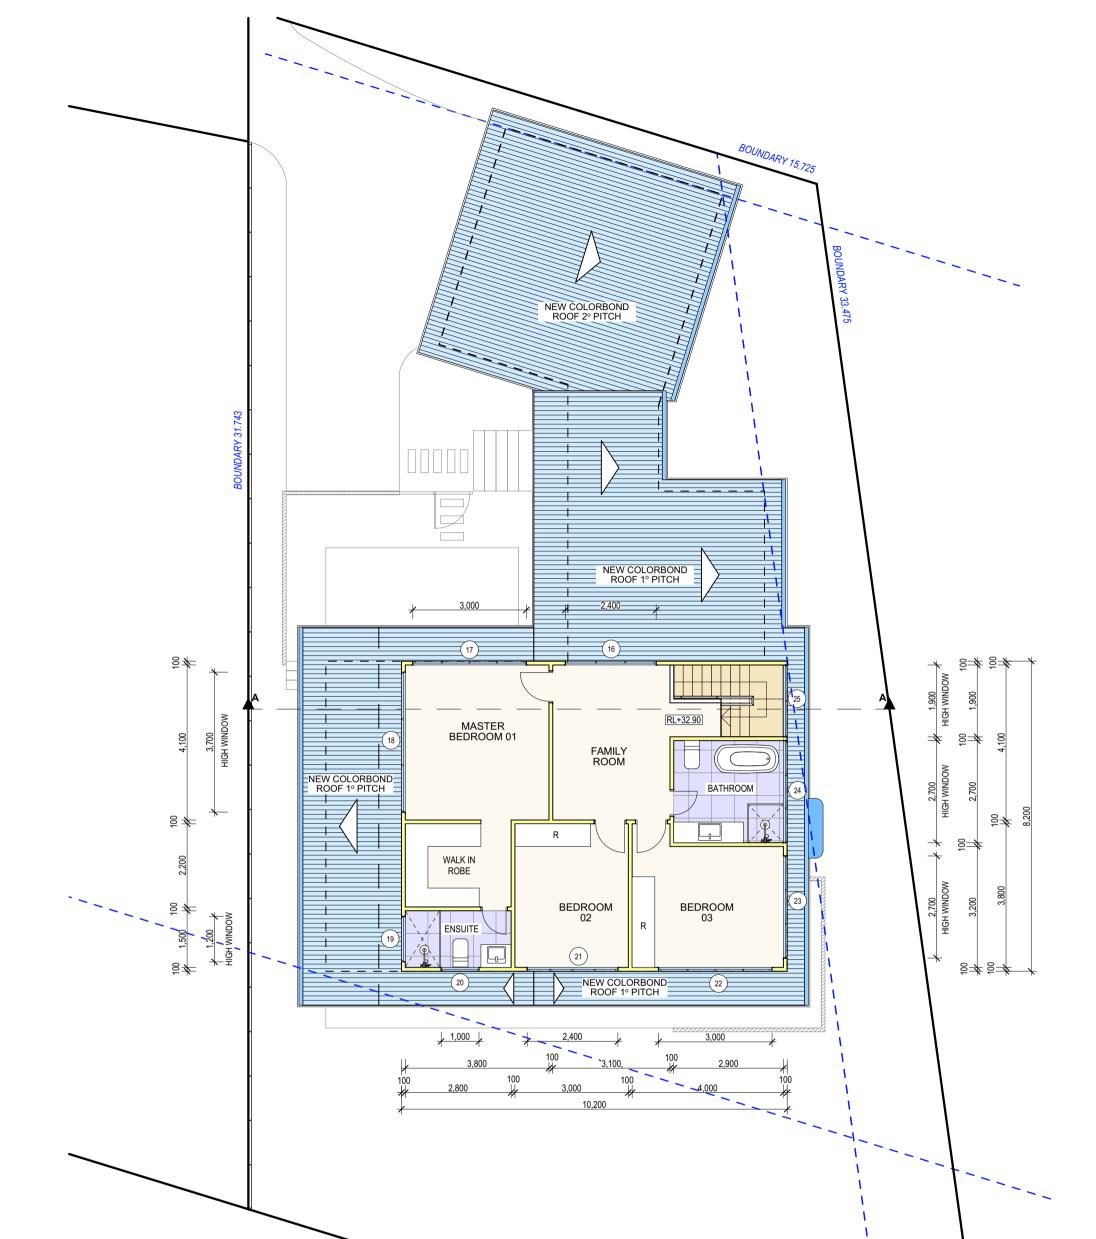

PROPOSED FIRST FLOOR PLAN

PROPOSED FIRST FLOOR AREA


= 78.65m²

TRUE NORTH:	NOTES (E & OE) All structures including stormwater & drainage to engineer's		PROJECT DETAILS:	DATE:	DRAWN BY:	SCALE:
	 All structures including stormwater & drainage to engineer's details. Do not obtain dimensions by scaling drawings. All dimensions are to be checked on site prior to starting work. These drawings are to be read in conjunction with all other consultant's drawings and specifications. 	JJ Drafting 174 Garden St, North Narrabeen, NSW, 2101	PROPOSED ALTERATIONS AND ADDITIONS 11B HILL STREET, WARRIEWOOD NSW 2102	SEPTEMBER/20	LB	1:100 @ A3
	\bullet All workmanship $\tilde{\&}$ materials shall be in accordance with the requirements of current editions including amendments of the	PO Box 687, Dee Why, NSW, 2099	DRAWING TITLE:	JOB No:	CHECKED BY:	DRAWING No:
National Construction Code, relevant Australian Standards & local council requirements. • New materials are to be used throughout unless otherwise noted. • Concrete footings, slab, structural beams or any other structural members are to be designed by a practicing engineer.	Email. jjdraft@tpg.com.au	FIRST FLOOR PLAN	854/20	LL	DA.05	

BOUNDARY 20.535




WEST ELEVATION

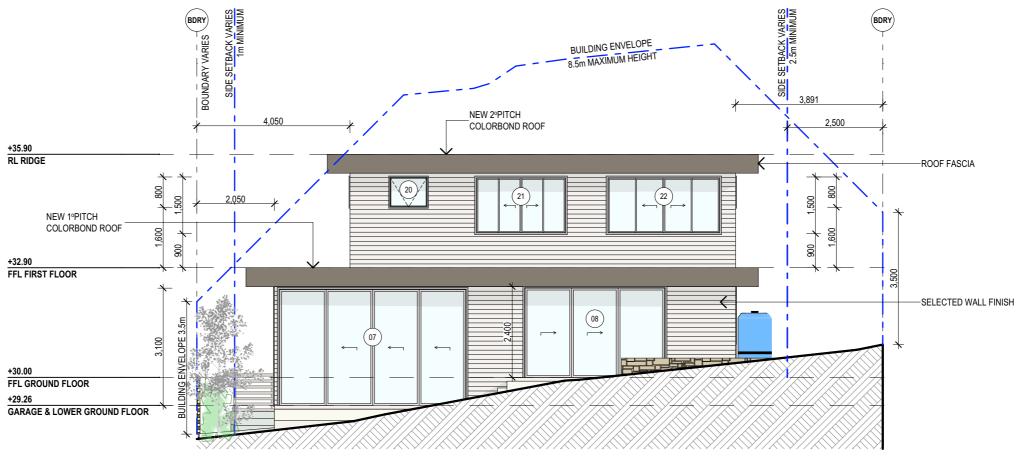


SOUTH ELEVATION

NOTES (E & OE) • All structures including stormwater & drainage to engineer's details. • Do not obtain dimensions by scaling drawings. • All dimensions are to be checked on site prior to starting work. • These drawings are to be read in conjunction with all other consultant's drawings and specifications.	JJ Drafting 174 Garden St, North Narrabeen, NSW, 2101	REV:	DATE:	DESCRIPTION:	PROJECT DETAILS: PROPOSED NEW DWELLING 11B HILL STREET, WARRIEWOOD NSW 2102	DATE: MARCH/21	DRAWN BY: LB	SCALE: 1:100 @ A3
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EAST ELEVATION

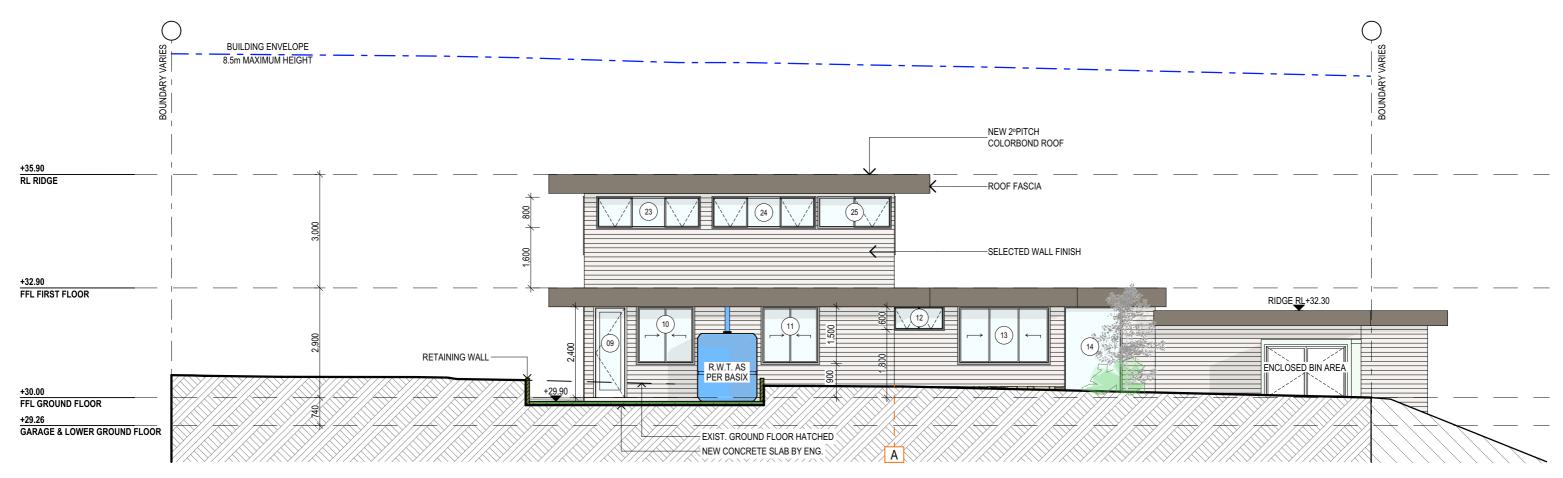

specifications. • All workmanship & materials shall be in accordance with the requirements of current editions An working share the strain be in accordance with the requirements of current evidons including amendments of the National Construction Code, relevant Australian Standards & local council requirements.
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by a practicing engineer.

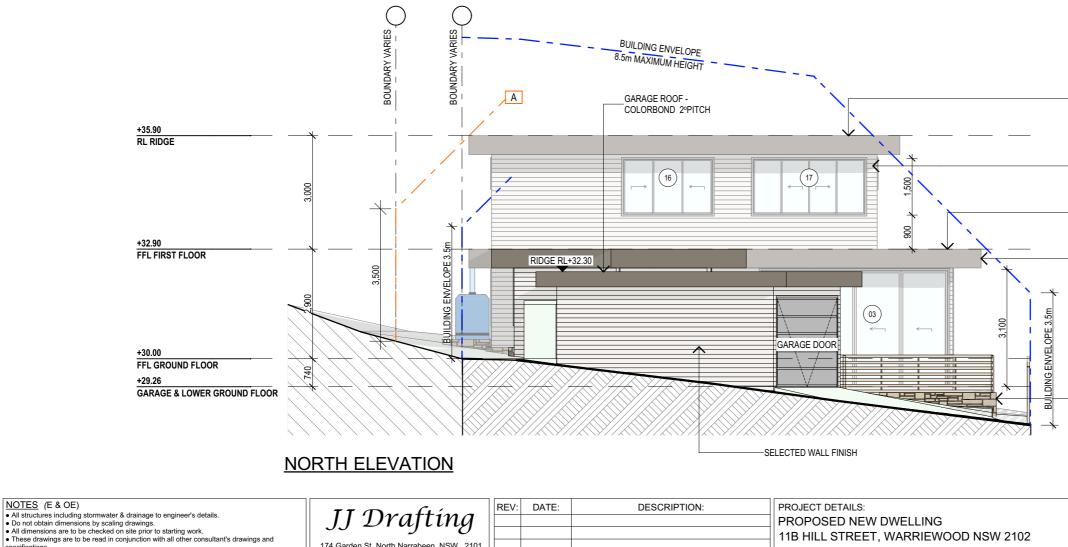174 Garden St, North Narrabeen, NSW, 2101 PO Box 687, Dee Why, NSW, 2099 Mob. 0414 717 541 Email. jjdraft@tpg.com.au www.jjdrafting.com.au

 11B HILL STREET, WARRIEWOOD NSW
DRAWING TITLE: EAST & NORTH ELEVATIONS

NEW 2°PITCH COLORBOND ROOF

-SELECTED WALL FINISH

-NEW 1ºPITCH COLORBOND ROOF

-ROOF FASCIA

-LOW RET. WALL BY ENG.

DATE:	DRAWN BY:	SCALE:
MARCH/21	LB	1:100 @ A3
JOB No:	CHECKED BY:	DRAWING No:
854/20	JJ	DA.07



SECTION AA

WATER COMMITMENTS:

FIXTURES

- SHOWERHEADS WITH A MINIMUM RATING OF 3STAR (>4.5 BUT < = 6l/min) IN ALL SHOWERS IN THE DEVELOPMENT TOILET FLUSHING SYSTEM WITH A MINIMUM RATING OF 4STAR IN ACH TOILET IN THE DEVELOPMENT.

- BASIN TAPS WITH A MINIMUM RATING OF 4STAR IN EACH BATHROOM IN THE DEVELOPMENT.

RAINWATER TANK

- RAINWATER TANK OF AT LEAST XXX LITRES ON THE SITE. HOT WATER

- GAS INSTANTANEOUS WITH A PERFORMANCE OF 6STARS.

ALTERNATIVE ENERGY

- PHOTOVOLTAIC SYSTEM WITH THE CAPACITY TO GENERATE AT LEAST 0.3 PEAK KILOWATTS OF ELECTRICITY AS PART OF THE DEVELOPMENT. CONNECTED TO THE DEVELOPMENT'S ELETRICAL SYSTEM.

OTHER

- GAS COOKTOP & ELECTRIC OVEN IN THE KITCHEN OF THE DWELLING. - REFRIGERATOR SPACE TO BE "WELL VENTILATED", AS DEFINED IN THE BASIX.

NOTES (E & OE)

by a practicing engineer.

specifications.

All structures including stormwater & drainage to engineer's details
 Do not obtain dimensions by scaling drawings.
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- FIXED OUTDOOR CLOTHES DRYING AS SHOWN ON PLAN.

SPECIFICATION NOTES:

EXTERNAL WALLS

- LIGHT FRAME WALLS FINISHED OFF WITH SELECTED CLADDING

DOORS AND WINDOWS

- TIMBER FRAMED WINDOWS AND DOORS - WEATHER STRIPPING IS TO BE PROVIDED TO ALL EXTERNAL WINDOWS AND DOORS

FLOORS - TIMBER FLOOR FRAMING TO BE FINISHED WITH T&G HARDWOOD FLOORING

- TILES ON COMPRESSED F.C. & WATERPROOF MEMBRANE TO ALL WET AREA.

<u>ROOFING</u> - COLORBOND ROOF CLADDING

BALUSTRADE - 1000mm HIGH BALUSTRADE TO BCA

- POOL FENCING 1.2m HIGH DECK

- TIMBER DECKING WITH ROUNDED EDGE & 3mm GAP BATHROOM

- ALL WATERPROOFING TO AS 3740

- PROVIDE A GUARANTEED FLEXIBLE WATERPROOF MEMBRANE TO ALL WET AREA FLOORS & SHOWERS WALLS TO MANUFACTURES INSTRUCTIONS

STORMWATER - NEW DOWNPIPES TO BE CONNECTED INTO EXISTING STORMWATER LINE

GUTTERS AND DOWNPIPES - COLORBOND GUTTERS AND DOWNPIPES - MINIMUM SLOPE OF EAVES AND GUTTERS 1:200

FLASHING AND CAPPINGS

- SELECTION AND INSTALLATION OF METAL RAINWATER GOODS REFER TO AS2180 - FLASH PROJECTIONS ABOVE THE ROOF WITH TWO PART FLASHINGS CONSISTING OF AN APRON FLASHING AND OVER FLASHING, WITH AT LEAST

100mm OVERLAP - PROVIDE FOR INDEPENDENT MOVEMENT BETWEEN ROOF AND PROJECTION

TERMITE CONTROL

- TO AS3660.1

TIMBER FRAMING

- USE TREATED TIMBER WHERE REQUIRED FOR DURABILITY - DO NOT USE TIMBER UNSUITABLE FOR EXPOSURE TO MOISTURE IN

- EXPOSED LOCATION
- ALL WORKMANSHIP AND MATERIALS SHALL BE IN ACCORDANCE WITH AS1684 AND 1720 AS APPLICABLE
- PROVIDE STRUCTURE BRACING IN ACCORDANCE WITH AS1684 - PROVIDE STRUCTURE TIEDOWN IN ACCORDANCE WITH AS1684 - USE GALVANISED FIXINGS WHERE EXPOSED TO WEATHER

CONCRETE

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- ALL WORKMANSHIP AND MATERIALS SHALL BE IN ACCORDANCE WITH CURRENT EDITIONS OF THE AS3600

- FOOTINGS TO BE IN ACCORDANCE WITH AS1480
- ALL REINFORCEMENTS SHALL CONFORM TO AS1302, AS1303, AS1304

REV: DATE: DESCRIPTION: PROJECT DETAILS: JJ Draftíng These drawings are to be read in conjunction with all other consultant's drawings and 174 Garden St, North Narrabeen, NSW, 2101 specifications.
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 Concrete footings, slab, structural beams or any other structural members are to be designed business of the structural members are to be designed business otherwise noted. PO Box 687, Dee Why, NSW, 2099 DRAWING TITLE: Mob. 0414 717 541 Email. jjdraft@tpg.com.au

INTERNAL LININGS

- PROVIDE PLASTERBOARD LINING

<u>STAIR</u>

- DRESSED & WELL SEASONED PINE TREADS WITH 5mm PENCIL ROUND NOSING AND CLOSED RISERS

SMOKE ALARMS

- CONNECT TO CONSUMER MAINS POWER AND INSTALL TO AS1670.6. 1997

(fire detection, warning control and intercom systems - systems design, installation and commissioning - smoke alarms) and as3786 -1996 (smoke alarms)

WASTE MANAGEMENT

- ALL WASTE SHALL BE TAKEN AWAY BY TRUCKS TO A SUITABLE LANDFILL OR RECYCLE DEPOT

- ALL WASTE SHALL BE COVERED DURING TRANSPORTATION - WASTE GENERATED DURING CONSTRUCTION SHALL BE PLACED IN STEEL BINS AND TAKEN AWAY BY AN APPROVED CONTRACTOR TO A APPROVED LANDFILL SITE

SEDIMENT CONTROL

- A FILTER CLOTH SYSTEM SHALL BE INSTALLED TO STOP ANY SEDIMENT ENTERING COUNCILS STORMWATER SYSTEM

NOTE:


ADDITIONS AND ALTERATIONS ARE TO BE READ IN CONJUNCTION AND COMPLY WITH THE BASIX CERTIFICATE, BUSHFIRE AND GEO TECH REPORTS.

PROPOSED NEW DWELLING 11B HILL STREET, WARRIEWOOD NSW 2102 SECTION & SPECIFICATION NOTES

-FLOOR STRUCTURE BY ENG.


WATERPROOF MEMBRANE

DATE:	DRAWN BY:	SCALE:
MARCH/21	LB	1:100 @ A3
JOB No:	CHECKED BY:	DRAWING No:
854/20	JJ	DA.08

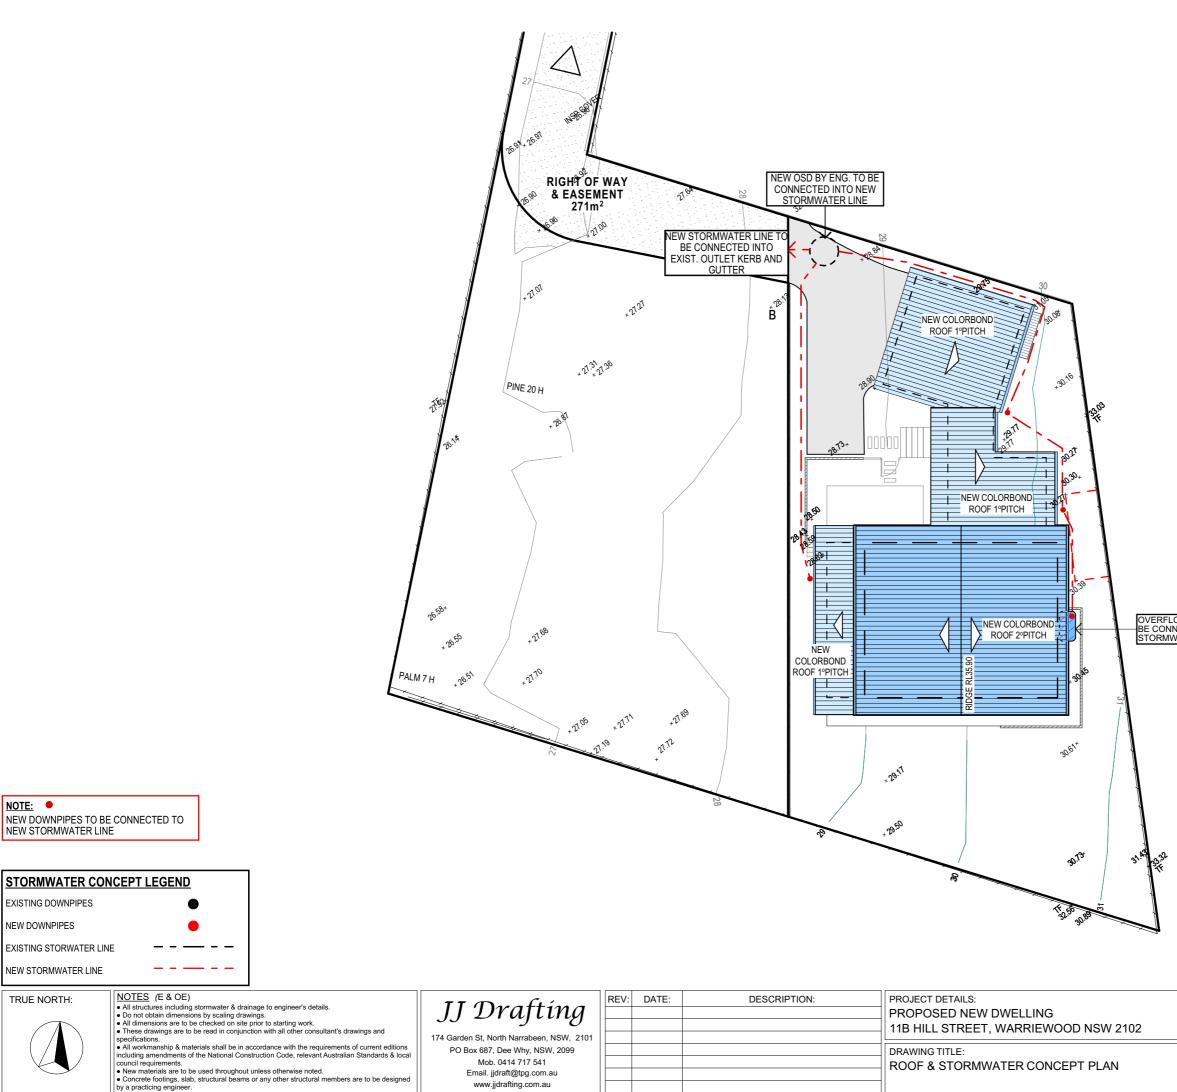

DATE:	DRAWN BY:	SCALE:
MARCH/21	LB	1:200 @ A3
JOB No:	CHECKED BY:	DRAWING No:
854/20	JJ	DA.09

OVERFLOW TO R.W.T. TO BE CONNECTED INTO STORMWATER LINE

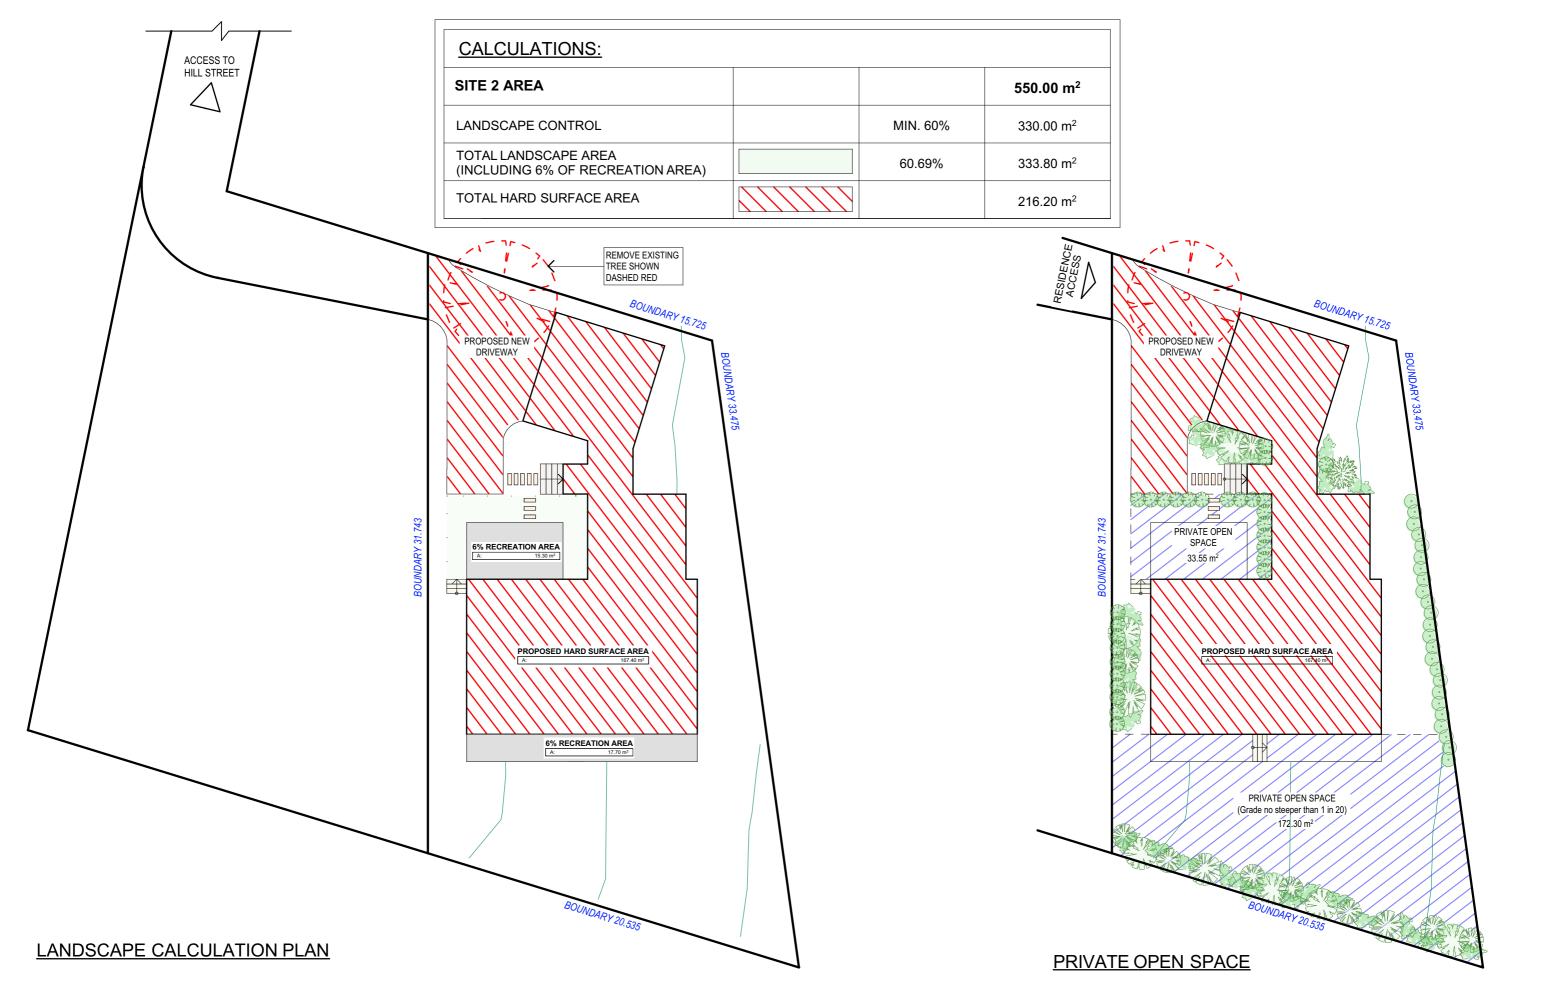

TRUE NORTH:	

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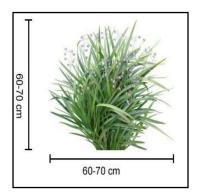
by a practicing engineer.

JJ Draftíng
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PO Box 687, Dee Why, NSW, 2099
Mob. 0414 717 541
Email. jjdraft@tpg.com.au
www.jjdrafting.com.au

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DATE:	DESCRIPTION:	PROJECT DETAILS: PROPOSED NEW DWELLING 11B HILL STREET, WARRIEWOOD NSW 2102	DATE: MARCH/21	DRAWN BY: LB	SCALE: 1:200 @ A3
		DRAWING TITLE: LANDSCAPE CALCULATION PLAN & PRIVATE OPEN SPACE	JOB No: 854/20	CHECKED BY: JJ	DRAWING No: DA.10

SYMBOL	COMMON NAME	SCIENTIFIC NAME	HEIGHT	SPREAD
$\overline{\mathbf{\cdot}}$	'WEEPING LILLY PILLY'	Waterhousea floribunda	5m	3m
	DIANELLA CAERULEA (BREEZE) or SIMILAR	Dianella caerulea	0.7m	0.7m
	PINK FLAIR CHERRY or SIMILAR	Prunus sargentii	2.5m	3.0m
	BIRD OF PARADISE AND/OR SELECTED TREE	Strelitzia nicolai	5m	3.5m
Ens	SELECTED SCRUBS AND PLANTS	-	-	-
(F)	EXISTING TREE TO REMAIN	-	-	-
Ð	EXISTING TREE TO BE REMOVED	-	-	-



DIANELLA CAERULEA (BREEZE)



BIRD OF PARADISE



'WEEPING LILLY PILLY'



PINK FLAIR CHERRY or SIMILAR



LANDSCAPE CONCEPT PLAN

TRUE NORTH:	NOTES (E & OE)	TT Des filse	REV:	DATE:	DESCRIPTION:	PROJECT DETAILS:
	 All structures including stormwater & drainage to engineer's details. Do not obtain dimensions by scaling drawings. 	JJ Drafting				PROPOSED NEW DWELLING
	All dimensions are to be checked on site prior to starting work.					11B HILL STREET, WARRIEWOOD NSW 2102
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	All workmanship & materials shall be in accordance with the requirements of current editions including analytical Construction Code, relevant Australian Standards & least	PO Box 687, Dee Why, NSW, 2099				DRAWING TITLE:
	including amendments of the National Construction Code, relevant Australian Standards & local council requirements.	Mob. 0414 717 541				LANDSCAPE CONCEPT PLAN
	New materials are to be used throughout unless otherwise noted.	Email. jjdraft@tpg.com.au				
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JOB No:	CHECKED BY:	DRAWING No:
854/20	JJ	DA.11

NOTES

DESIGNATED SITE MANAGER/BUILDER

PRIOR TO COMMENCEMENT OF WORK A SITE MANAGER OR BUILDER MUST BE NOMINATED. THE SITE MANAGER OR BUILDER WILL BE RESPONSIBLE AND LIABLE FOR ALL WORKS CARRIED OUT ON THE SITE. THIS ASSUMES THE RESPONSIBILITY FOR THE ACTIONS OF ALL SUBCONTRACTED PARTIES AS WELL AS ADVISING THEM OF COUNCIL'S REQUIREMENTS WHEN CARRYING OUT WORKS.

TOPSOIL MANAGEMENT

PRIOR TO THE STRIPPING OF TOPSOIL, THE VEGETATIVE COVER MUST BE REDUCED BY EITHER SLASHING OR MOWING. ALL TOPSOIL IS TO BE RETAINED AND PROTECTED FOR REUSE ON SITE. SOIL STOCKPILES MUST NOT BE LOCATED ON NATURE STRIPS, FOOTPATHS, ROADWAYS, KERBS, ACCESSWAYS, WITHIN DRAINAGE LINES/FLOWS/PATHS OR AROUND OR AGAINST TREE SHRUBS. SEDIMENT CONTROL MEASURES MUST BE INCORPORATED WITH ANY RESULTING STOCKPILE. THE STOCKPILE CAN BE PROTECTED FROM EROSION BY COVERING IT WITH AN IMPERVIOUS MATERIAL, IN CONJUNCTION WITH THE INSTALLATION OF A SEDIMENT FENCE AROUND IT. IF STOCKPILES ARE TO REMAIN FOR MORE THAN ONE MONTH THEY ARE TO BE GRASSED IMMEDIATELY AND STABILISED WITHIN FOURTEEN DAYS. SURPLUS TOPSOIL MUST BE REASONABLY REMOVED FROM SITE.

BUILDING MATERIAL STOCKPILING

SUFFICIENT AREA MUST BE ALLOCATED WITHIN THE SITE FOR SUCH STORAGE OF BUILDING MATERIALS, DEMOLITION WASTE, WASTE CONTAINERS, ETC. AS WILL BE REQUIRED.

SEDIMENT FENCES

A SEDIMENT FENCE SHOULD BE LOCATED ALONG THE DOWNSLOPE BOUNDARY(S) OF THE SITE, ON THE CONSTRUCTION SIDE OF THE TURF FILTER STRIP OR NATIVE VEGETATION, AND AROUND ALL STOCKPILES OF MATERIAL ON THE SITE.

DUST CONTROL

ALL TRUCKS/UTES MUST COVER THEIR LOADS AT ALL TIMES. APPROPRIATE METHODS ARE TO BE EMPLOYED TO PREVENT BLOWING DUST CREATING AN UNACCEPTABLE HAZARD OR NUISANCE ON THE SITE OR DOWN WIND. PRODUCTION OF DUST CAN BE MINIMISED BY LIMITING AREA OF EARTHWORKS, WATERING AND PROGRESSIVE VEGETATION. WHERE DUST IS CREATED AS A RESULT WORKS AND/OR SOIL EXPOSURE, THE BARE SOIL AREAS MUST BE WATERED, DURING AND/OR AT THE END OF EACH DAY TO LAY THE DUST. EARTH MOVING ACTIVITIES SHOULD BE AVOIDED WHERE WINDS ARE SUFFICIENTLY STRONG ENOUGH TO RAISE VISIBLE DUST.

EROSION & SEDIMENT CONTROLS

APPROPRIATE EROSION AND SEDIMENT CONTROLS MUST BE IMPLEMENTED ON ALL SITES THAT INVOLVE SOIL DISTURBANCE. THE MEASURES MUST BE IN PLACE PRIOR TO THE COMMENCEMENT OF WORK. THOSE CONTROLS ARE TO BE MONITORED AND MAINTAINED IN ORDER TO SERVE THEIR INTENDED FUNCTION FOR THE DURATION OF THE WORKS OR UNTIL SUCH TIME AS THE SITE IS FULLY STABILISED. IF ANY CONTROLS ARE DAMAGED OR BECOME INEFFECTIVE DURING THE COURSE OF THE WORKS THEY ARE TO BE REINSTATED OR REPLACED IMMEDIATELY. SUFFICIENT ACCESS TO THESE CONTROLS MUST BE PROVIDED IN CASE OF THE NEED TO REPAIR.

SEDIMENT TRAPS

WHERE A SEDIMENT FENCE IS NOT USED APPROPRIATE SEDIMENT TRAPS SHOULD BE LOCATED AT ALL POINTS WHERE STORMWATER LEAVES THE CONSTRUCTION SITE OR LEAVES THE GUTTER AND ENTERS THE DRAINAGE SYSTEM. A COMMON TECHNIQUE IS THE GRAVEL SAUSAGE.


DIVERSION CHANNELS

A DIVERSION CHANNEL IS AN EXCAVATED EARTH DITCH OR PATH. THESE STRUCTURES ARE USED TO INTERCEPT AND DIRECT RUN-OFF TO A DESIRED LOCATION WHERE POSSIBLE. ALL STORMWATER RUN-OFF FLOWING ONTO DISTURBED AREAS, INCLUDING STOCKPILES, MUST BE INTERCEPTED, DIVERTED AND/OR SAFELY DISPOSED OF. THIS CAN BE ACHIEVED BY CONSTRUCTING A TEMPORARY EARTH BANK AROUND THE UPSLOPE EXTENT OF THE CONSTRUCTION SITE WHERE THE DIVERSION DOES NOT AFFECT THE NEIGHBOURING PROPERTIES.

VEHICLE MOVEMENTS

TO LIMIT DISTURBANCE TO THE SITE AND TRACKING OF MATERIAL ONTO THE STREET ALL VEHICLES AND PLANT EQUIPMENT ARE TO USE A SINGLE ENTRY/EXIT POINT UNLESS COUNCIL HAS APPROVED ALTERNATIVE ARRANGEMENTS. ACCESS POINTS AND PARKING AREAS ARE TO BE STABILISED WITH COMPACTED SUB-GRADE ASAP AFTER THEIR FORMATION. IF SPILLAGE DOES OCCUR IT IS TO BE CONTAINED IMMEDIATELY AND CAREFULLY REMOVED. THE AREA AFFECTED IS TO BE RESTORED TO A STANDARD EQUAL TO OR BETTER THAN ITS PREVIOUS CONDITION. ALL VEHICLES ARE TO BE WASHED PRIOR TO EXISTING THE SITE. THIS SERVES THE PURPOSE OF REMOVING SITE MATERIAL ON THE VEHICLE AND PREVENTS IT FROM BEING DEPOSITED ON THE ROAD NETWORK ADJACENT TO THE SITE AND THUS, THE STORMWATER SYSTEM. NO VEHICLE ASSOCIATED WITH THE WORK IS TO BE PARKED ON A FOOTPATH OR PUBLIC RESERVE. ALL VEHICLES VISITING THE SITE DURING DEMOLITION, EXCAVATION AND/OR CONSTRUCTION WORKS, ARE TO COMPLY WITH THE PARKING REQUIREMENTS IN THAT AREA.

by a practicing engineer

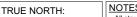

	NOTES (E & OE)	
	All structures including stormwater & drainage to engineer's details.	
	Do not obtain dimensions by scaling drawings.	
	 All dimensions are to be checked on site prior to starting work. 	
\backslash	 These drawings are to be read in conjunction with all other consultant's drawings and specifications. 	
	All workmanship & materials shall be in accordance with the requirements of current editions	
/	including amendments of the National Construction Code, relevant Australian Standards & local council requirements.	
	 New materials are to be used throughout unless otherwise noted. 	
	Concrete footings, slab, structural beams or any other structural members are to be designed	

 TYPICAL DIVERSION CHANNEL
 - nts


 DRAINAGE AREA 4ha MAX. HEIGHT 0.6m MAX.
SPILLWAY AT LEAST 0.15m BELOW SIDEs.

 BATTER SLOPE 1:2 OR LESS
 +

 DIRECTION
OF FLOW


 COURSE AGGREGATE
WRAPPED IN GEOTEXTILE

TYPICAL SEDIMENT FENCE - nts

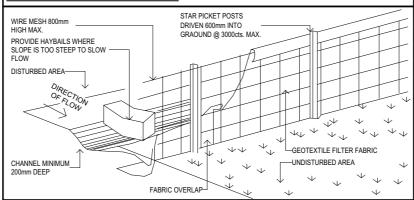

REV: DATE:

DESCRIPTION:

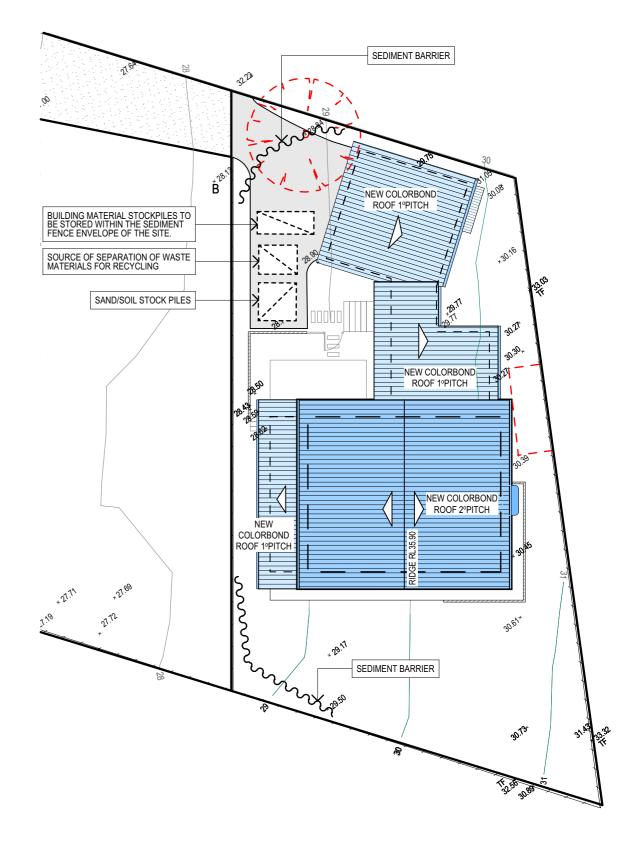


EROSION & SEDIMENT CONTROL/ WASTE MANAGEMENT PLAN


PROJECT DETAILS: PROPOSED NEW DWELLING 11B HILL STREET, WARRIEWOOD NSW 2102	DATE: MARCH/21	DRAWN BY: LB	SCALE: 1:200 @ A3
DRAWING TITLE: EROSION & SEDIMENT CONTROL / WASTE MANAGEMENT PLAN	JOB No: 854/20	CHECKED BY: JJ	DRAWING No: DA.12



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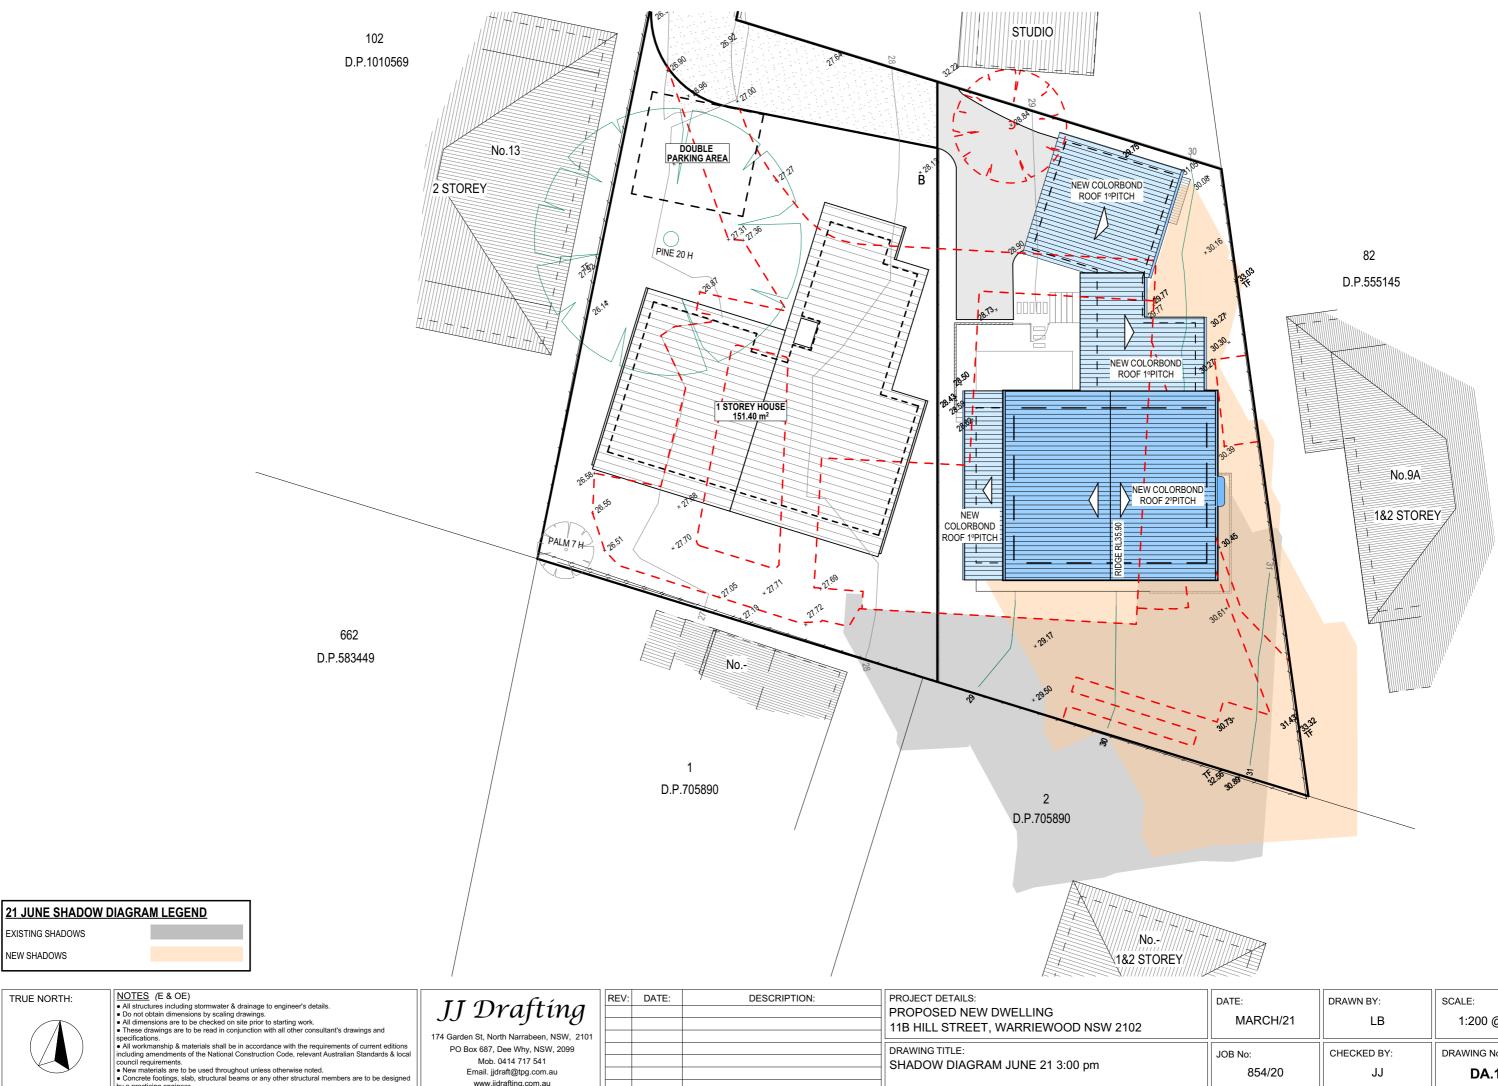


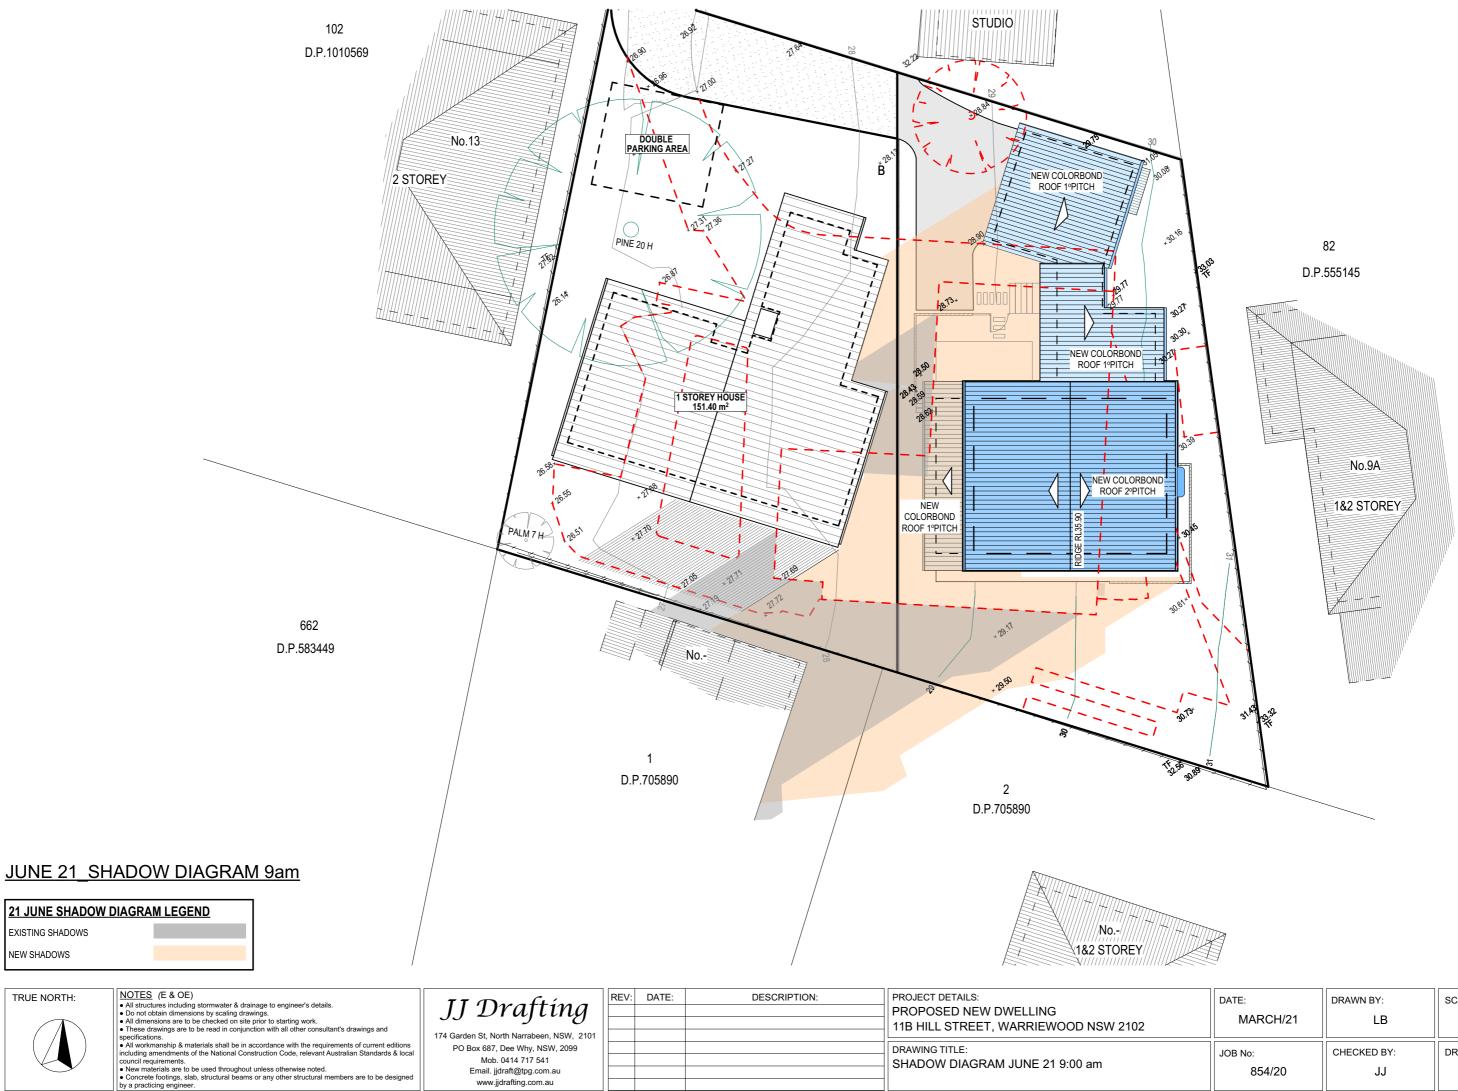•	New materials are t	to be	used thro	ughout	unless	other	wise noted	1.				
•	Concrete footings, s	slab,	structural	beams	or any	other	structural	members	are to l	be (designe	c
2	v a practicing engine	Per										

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DRAWING TITLE: SHADOW DIAGRAM JUNE 21 12 noon

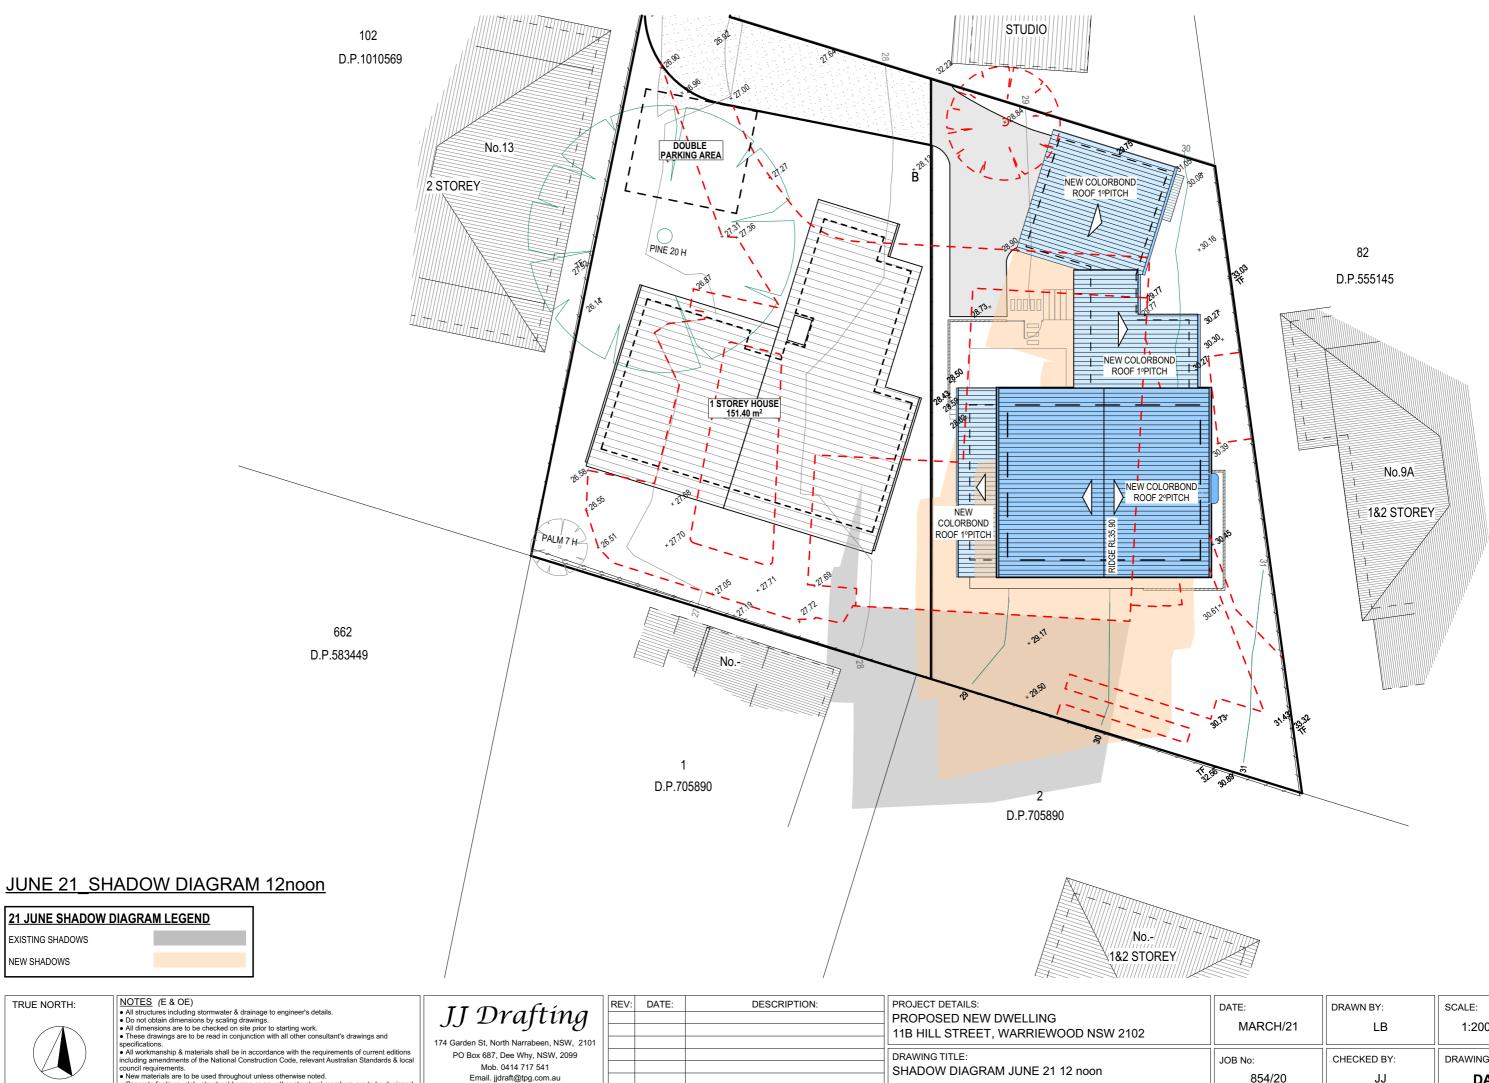DATE:	DRAWN BY:	SCALE:
MARCH/21	LB	1:200 @ A3
JOB No:	CHECKED BY:	DRAWING No:
854/20	JJ	DA.14



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EXISTING SHADOWS

NEW SHADOWS

TRUE NORTH:

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APPENDIX B Swept Path Assessments and Proposed Stop and Go Light System

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